

WAR MEMORIAL FIELD IMPROVEMENTS PHASE IIA, SPRING FACILITIES ADDENDUM NO. 1

DATE: October 9, 2020

BID OPENING: Thursday, October 15 @ 2:00:00 P.M.

PAGES: Addendum (2 pages)

Drawings (4 sheets)

Acknowledge receipt of this Addendum by inserting its number and date on the Bid Form. Failure to do so may subject bidder to disqualification. This Addendum forms a part of the Contract Documents. It modifies the Contract Documents as follows:

PART 2, INSTRUCTIONS TO BIDDERS

ARTICLE 17 – EVALUATION OF BIDS AND AWARD OF CONTRACT

Add new Article 17.07 immediately following Article 17.06:

17.07 In accordance with Idaho Administrative Procedures Act (IDAPA) 38.05.01, criteria used to determine responsible Bids may include the following, as determined by the Owner:

A. Standards of Responsibility:

- a. Availability of the appropriate financial, material, equipment, facility, and personnel resources and expertise, or the ability to obtain them, necessary to indicate capability to meet all contractual requirements;
- b. A satisfactory record of integrity;
- c. Qualified legally to contract with the procurement activity and qualified to do business in the State of Idaho;
- d. Unreasonably failed to supply any necessary information in connection with the inquiry concerning responsibility;

- e. Requisite experience;
- f. A satisfactory prior performance record, if applicable; or
- g. Difference between the Bidder and the mean of all other bids received.

PART 7, SPECIAL PROVISIONS

DIVISION 700 - CONCRETE

SECTION 703 – CAST-IN-PLACE CONCRETE

PART 3 – WORKMANSHIP

Delete paragraph 3.5.C in its entirety and replace with the following:

C. Protect and cure concrete for minor structures such as sign foundations, sidewalks, curb and gutter, small irrigation boxes, etc. in cold weather as required in Section 3.2.

.....

PART 8, CONTRACT DRAWINGS

Replace Drawings G0.0, L1.0, L1.1, and L1.2 with revised versions (attached).


END OF ADDENDUM NO. 1

WAR MEMORIAL FIELD IMPROVEMENTS PHASE IIA PROJECT LOCATION - SANDPOINT, IDAHO

801 ONTARIO STREET SANDPOINT, IDAHO 83864

CONSTRUCTION DRAWINGS 100% BID SET 09-29-2020



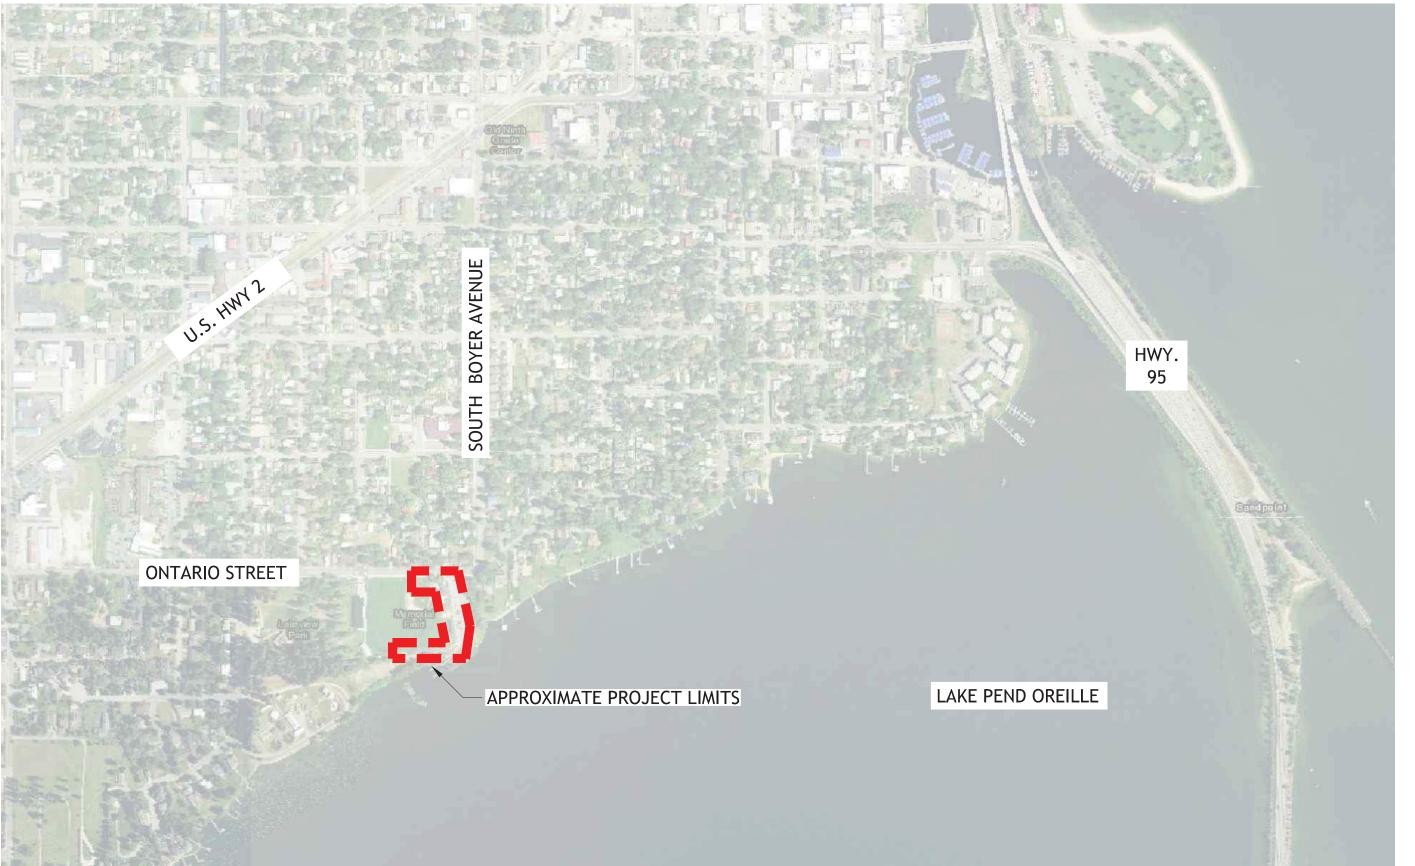



VICINITY MAPS (NTS):

SHEET INDEX

GENERAL:

G0.0 COVER SHEET & SHEET INDEX

CIVIL:

C1.1 SITE PLAN C1.2 **GRADING PLAN** C1.3 GRADING PLAN GRADING PLAN CIVIL DETAILS C2.2 CIVIL DETAILS C3.1 EROSION CONTROL PLAN C3.2 **EROSION CONTROL DETAILS**

LANDSCAPE:

L1.0 MATERIALS PLAN (OVERALL) L1.1 MATERIALS PLAN (NORTH) L1.2 MATERIALS PLAN (SOUTH) L2.0 LAYOUT PLAN (OVERALL) L2.1 LAYOUT PLAN (NORTH) L2.2 LAYOUT PLAN (SOUTH) L6.0 LANDSCAPE SITE DETAILS L6.1 LANDSCAPE SITE DETAILS L6.2 LANDSCAPE SITE DETAILS LANDSCAPE SITE DETAILS L6.3

STRUCTURAL:

GENERAL NOTES/DETAILS



PROJECT CONTACTS

CITY OF SANDPOINT CITY ENGINEER/PROJECT MANAGER DAN TADIC: PE, (208) 263-3577

BERNARDO WILLS ARCHITECTS

ARCHITECT/LANDSCAPE ARCHITECT (PRIME CONSULTANT) DELL HATCH: PLA/PRINCIPAL, LANDSCAPE ARCHITECT JAMES DAVIS: PLA/PROJECT LANDSCAPE ARCHITECT

WELCH COMER ENGINEERS

SURVEYOR/CIVIL ENGINEER (SUB CONSULTANT) PHIL BOYD: PE/PRINCIPAL NATHAN WRIGHT: PROJECT ENGINEER

COFFMAN ENGINEERS

ELECTRICAL ENGINEER (SUB CONSULTANT) ZACHARY YARBROUGH: PE

ECLIPSE ENGINEERING

STRUCTURAL ENGINEER (SUB CONSULTANT) BRIAN HANSON: PE/PRINCIPAL


Field : - Phase Facilities

War Memorial F Improvements Spring Facilities 801 Ontario Street Sandpoint, Idaho 83864 S

 \leq 0 \propto ARCHITECTS Z \simeq $\mathbf{\Omega}$

 \blacksquare

Project No: 19-10-207 Drawn by:

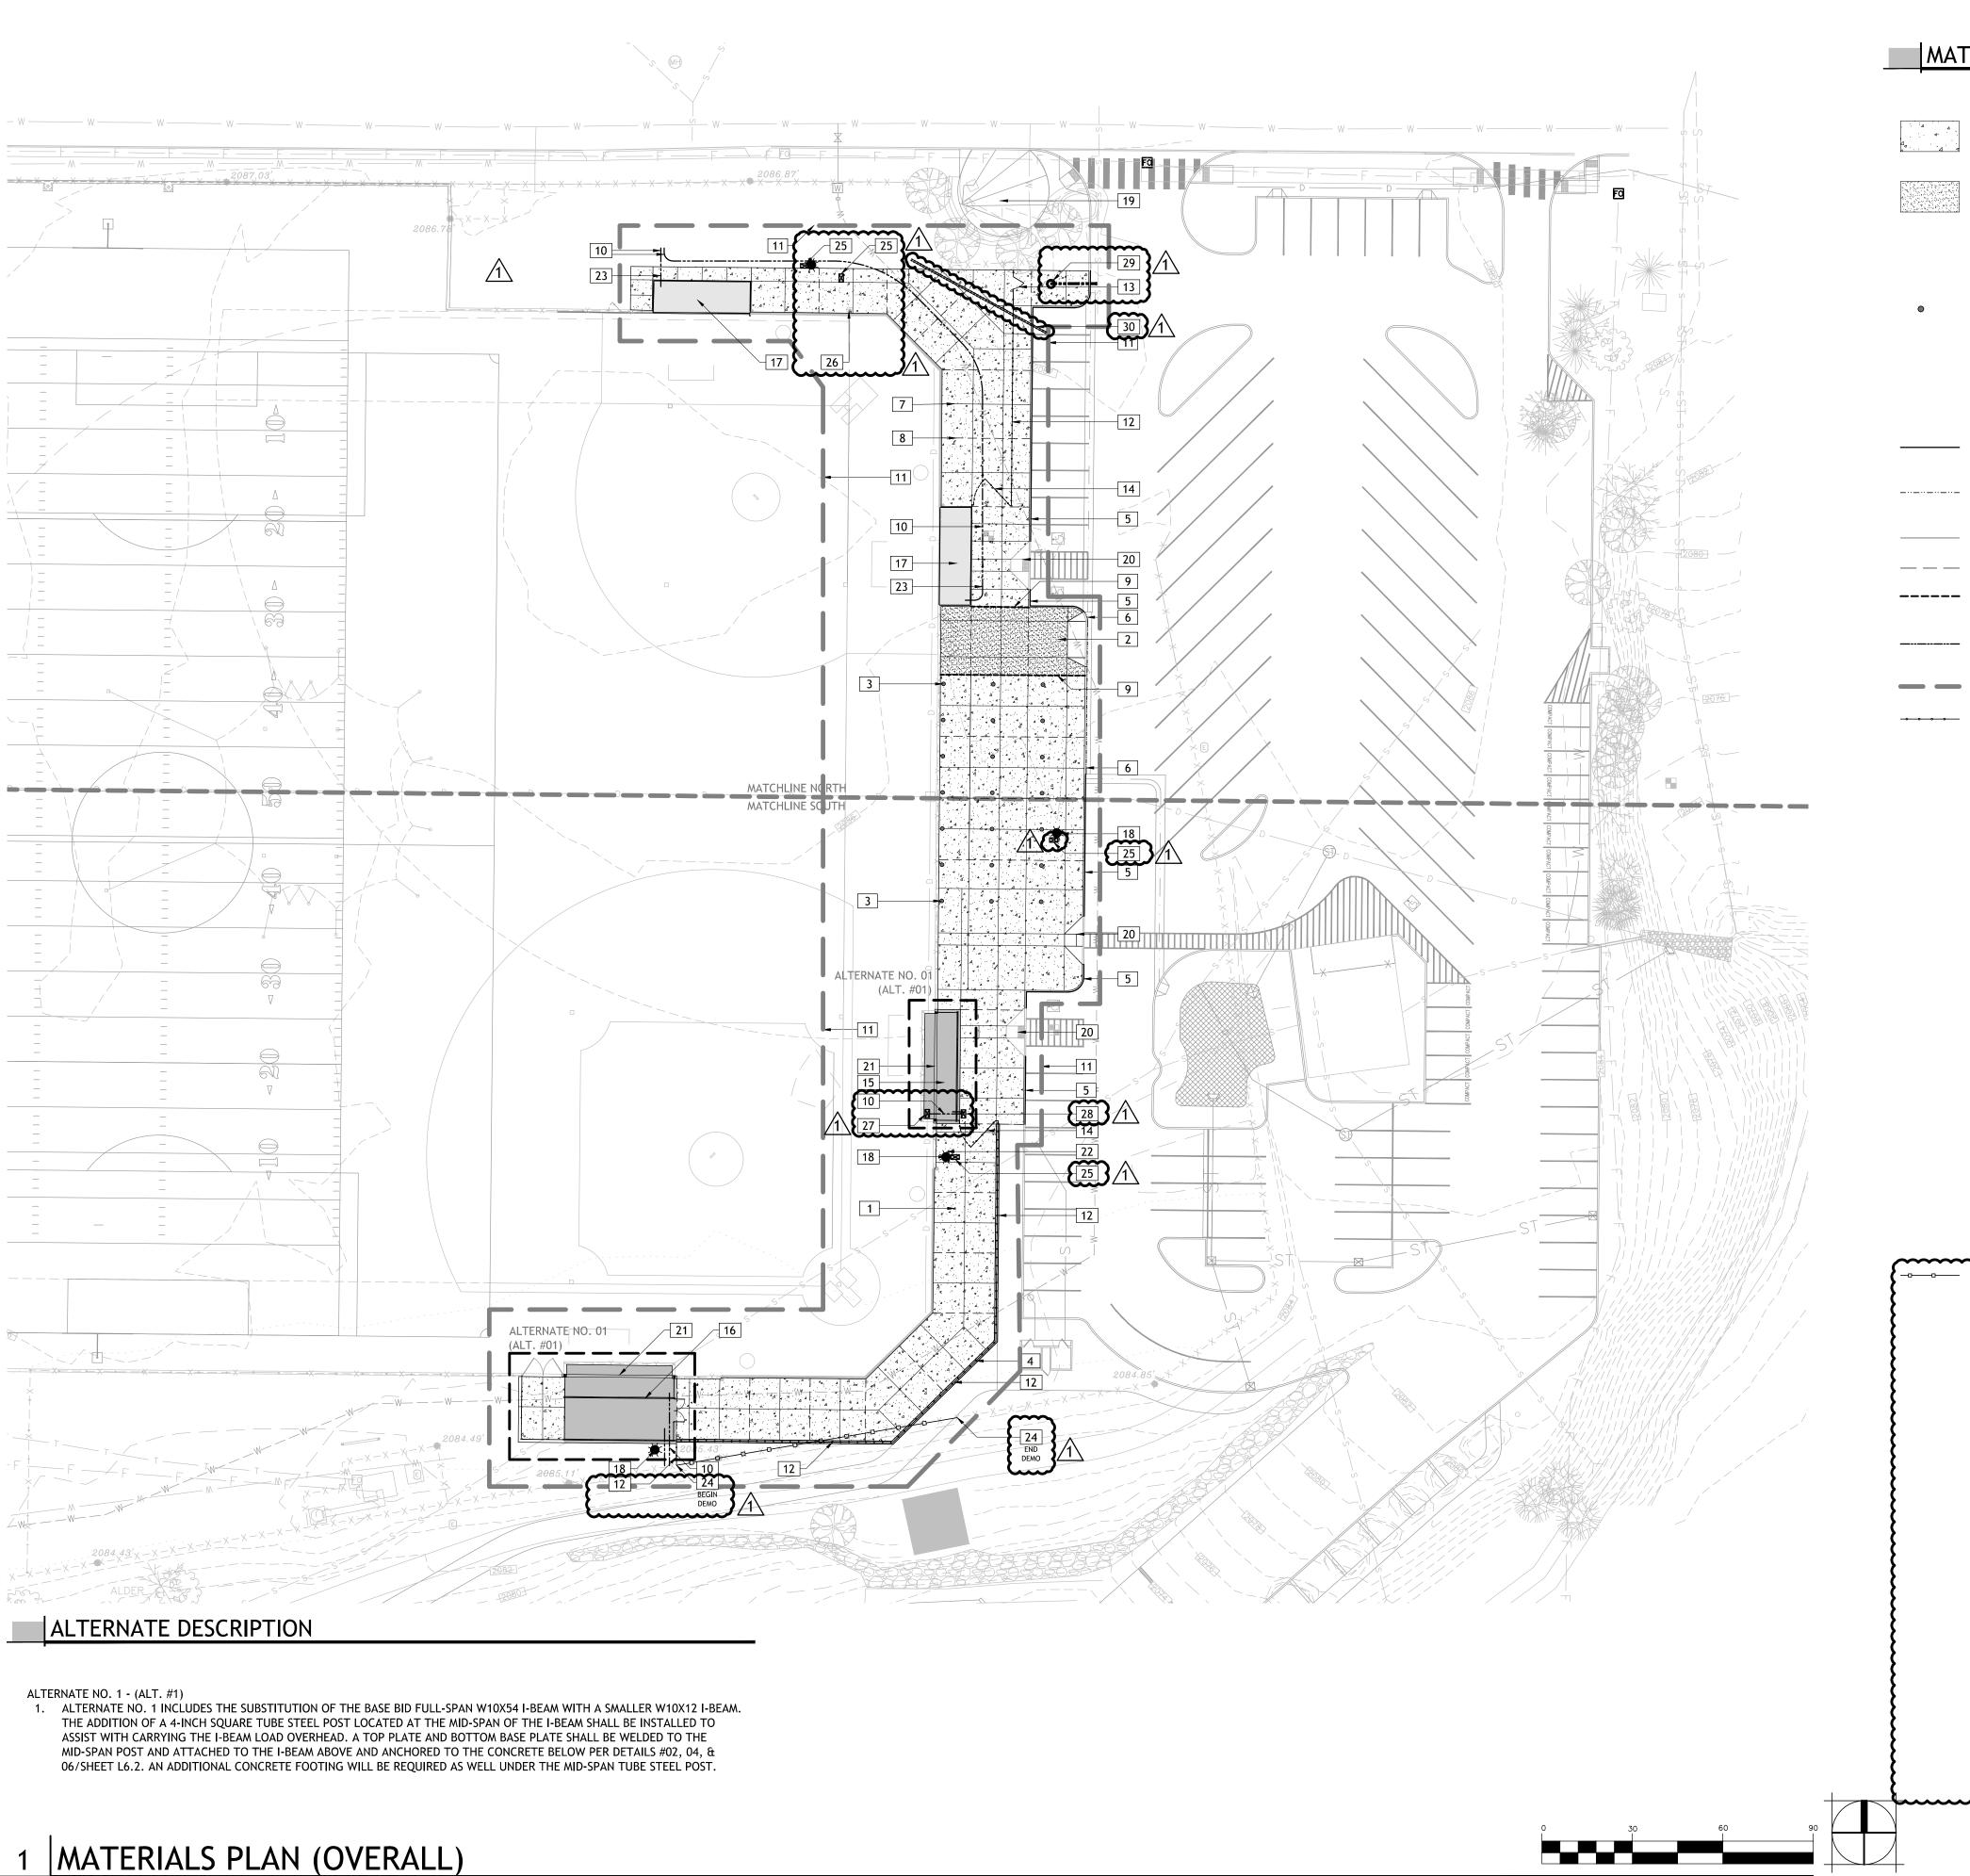

MATE	RIALS L	EGEND	
·	SYMBOL	DESCRIPTION	QTY
4	1	(4") STANDARD CONCRETE FLATWORK. BROOM FINISH. COLOR SHALL BE NATURAL GREY - (SEE DETAIL #01/SHEET L6.0)	14,187 SF
	2	(6") THICKENED CONCRETE FLATWORK AT TRUCK DRIVE APPROACH. #4 REBAR AT 12" O.C. BROOM FINISH, COLOR SHALL BE NATURAL GREY - (SEE DETAILS #02/SHEET L6.0 & CIVIL SHEETS C1.2 & DETAIL #03/SHEET C2.1)	990 SF
	SYMBOL	DESCRIPTION	QTY
•	3	CONCRETE EMBEDDED GROUND SLEEVE FOR BATTING CAGE POSTS. 2-3/8" O.D. X 27" DEEP SLEEVE W/ HINGED ALUMINUM CAP - (SEE DETAIL #06/SHEET L6.0)	21
	4	NEW CAST-IN-PLACE CONCRETE RETAINING WALL W/ EMBEDDED FENCE POSTS - (SEE STRUCTURAL SHEETS & DETAIL #01/SHEET S0.1. SEE DETAILS #01-04/SHEET L6.3) DAYLIGHT PER CIVIL PLANS	192 LF
	5	CONCRETE VERTICAL CURB - (SEE CIVIL SHEETS & DETAIL #01/SHEET C2.1)	245 LF
	6	CONCRETE CURB & GUTTER - (SEE CIVIL SHEETS & DETAIL #02/SHEET C2.1)	67 LF
	7	CONCRETE CONTROL JOINT, TYP (SEE DETAIL #04/SHEET L6.0)	2,123 LF
	8	CONCRETE EXPANSION JOINT, TYP (SEE DETAIL #05/SHEET L6.0)	637 LF
	9	CONCRETE W/ THICKENED EDGE & EXPANSION JOINT W/ DOWEL & GREASE SLEEVE - (SEE DETAIL #03/SHEET L6.0)	80 LF
	10	(1") SCHEDULE 40 PVC ELECTRICAL CONDUIT, STUB UP & CAP ENDS. CONDUIT DEPTH PER ELECTRICAL CODE, MINIMUM (18-INCHES)	328 LF
	11	PROJECT WORK BOUNDARY EXTENTS	\sim
	12	6FT. GALVANIZED CHAINLINK FENCE - (SEE SPECIFICATIONS & DETAIL #07/SHEET L6.0)	300 LF) ^{/-}
	13	6FT. HT. X 4FT WIDE SINGLE SWING CHAINLINK GATE - (SEE DETAIL #08/SHEET L6.0)	
	14	6FT. HT. X 12FT. WIDE SINGLE SWING CHAINLINK GATE - (SEE DETAIL #08/SHEET L6.0)	
	15	FIRST BASE BASBALL DUGOUT - (SEE DETAILS #01, 02, 03, 05, 06, & 07/SHEET L6.1)	
	16	THIRD BASE BASEBALL DUGOUT & STORAGE STRUCTURE - (SEE DETAILS #03 - #07/SHEET L6.1 & DETAILS 01, 03, & 05/SHEET L6.3)	
	17	EXISTING SOFTBALL DUGOUT TO REMAIN (PHASE I)	
	18	EXISTING LIGHT FIXTURE TO REMAIN (PHASE I)	
	19	EXISTING WAR MEMORIAL - PRESERVE & PROTECT	
	20	ADA COMPLIANT STANDARD CAST IRON TACTILE WARNING TILES & PEDESTRIAN RAMP - (SEE CIVIL SHEETS & DETAIL SHEET C2.2)	
	21	ALTERNATE NO. 01 (ALT. #01) - SUBSTITUTE THE BASE BID FULL-SPAN W10X54 STEEL I-BEAM WITH (2) TWO MID-SPAN W10X12 STEEL I-BEAMS W/ ADDITIONAL ADDED CENTER SUPPORT TUBE STEEL POST WITH TOP & ANCHOR PLATE - (SEE DETAILS #02, 04, & 06/SHEET L6.3) FOR ADDITIONAL INFORMATION	
	22	REMOVE HAND HOLE & EXTEND (1") SCHEDULE 40 PVC ELECTRICAL CONDUIT TO SOUTHEAST CORNER BEHIND BENCH, & NORTH OF BAT/HELMET RACK. STUB UP & CAP	
	23	EXTEND EXISTING (1") SCHEDULE 40 PVC ELECTRICAL CONDUIT FROM DUGOUT TO THE NORTH TO CLEAR THE FLATWORK AREA	
-	24	DEMO EXISTING CHAINLINK FENCE. INCIDENTAL TO EXCAVATION AND HAUL OFF-SITE PAY ITEM	107 LF
	25	PHASE I ELECTRICAL HANDHOLE. INSTALL NEW BOX AT SAME LOCATION W/ TRAFFIC RATED STEEL OR CONCRETE LID (SUBMIT TO ENGINEER & LANDSCAPE ARCHITECT FOR APPROVAL). SET IN-LINE TO PHASE 2A CONCRETE FLATWORK AND ADJUST TO FINISH GRADE. INCIDENTAL TO CONCRETE FLATWORK PAVEMENT PAY ITEM	
	26	PHASE I FOUL POLE. REMOVE TEMPORARY BOX & COVER INSTALLED AROUND FOUL POLE BASE DURING PHASE I AND INSTALL O.F.C.I. (OWNER FURNISHED, CONTRACTOR INSTALLED) REMOVABLE FOUL POLE BOX W/ACCESS HATCH. THIS COST SHALL BE INCIDENTAL TO THE CONCRETE FLATWORK PAVEMENT PAY ITEM	
}	27	REMOVE EXISTING HANDHOLE. INCIDENTAL TO CONCRETE FLATWORK PAVEMENT PAY ITEM	}
	28	INSTALL NEW HANDHOLE W/ TRAFFIC RATED STEEL OR CONCRETE LID (SUBMIT TO ENGINEER & LANDSCAPE ARCHITECT FOR APPROVAL) DIRECTLY EAST OF BATTING CAGE. SET IN-LINE TO PHASE 2A CONCRETE FLATWORK AND ADJUST TO FINISH GRADE. RE-ROUTE PHASE I WIRE/CONDUIT TO THIS LOCATION AND ROUTE CONDUIT TO INSIDE BATTING CAGE. INCIDENTAL TO CONCRETE FLATWORK PAVEMENT PAY ITEM	
	29	APPROXIMATE LOCATION OF THREE (3) 1-INCH UNDERGROUND PHASE I ELECTRICAL CONDUITS 5FT. SOUTH, AND 20FT. EAST OF FROST-FREE WATER SPIGOT. CAREFULLY POTHOLE/EXCAVATE & EXTEND CONDUITS PAST PHASE 2A CONCRETE FLATWORK EXTENT TO THE EAST MINIMUM 3FT. BEYOND	
}	30	INSTALL 6-INCH DIAMETER CLASS 200 PVC SLEEVE FOR FUTURE IRRIGATION MAINLINE ROUTING. INCIDENTAL TO CONCRETE FLATWORK PAVEMENT PAY ITEM	\$

PAVEMENT PAY ITEM

NORTH

* ALL QUANTITIES PROVIDED SHALL BE CONFIRMED BY CONTRACTOR AND ARE SHOWN FOR REFERENCE ONLY. IN THE CASE OF A DISCREPANCY BETWEEN THE SCHEDULE AND PLAN, THE PLAN LOCATION(S) SHALL DICTATE QUANTITY.*


WILLS
War Memoi

BERNARDO | WIL

Project No: 19-10-207
Drawn by: JD

Date: 09-29-20

SCALE: 1" = 30'-0" @ 22"x34" (FULL SIZE) | 1" = 60'-0" @ 11"x17" (HALF SIZE)

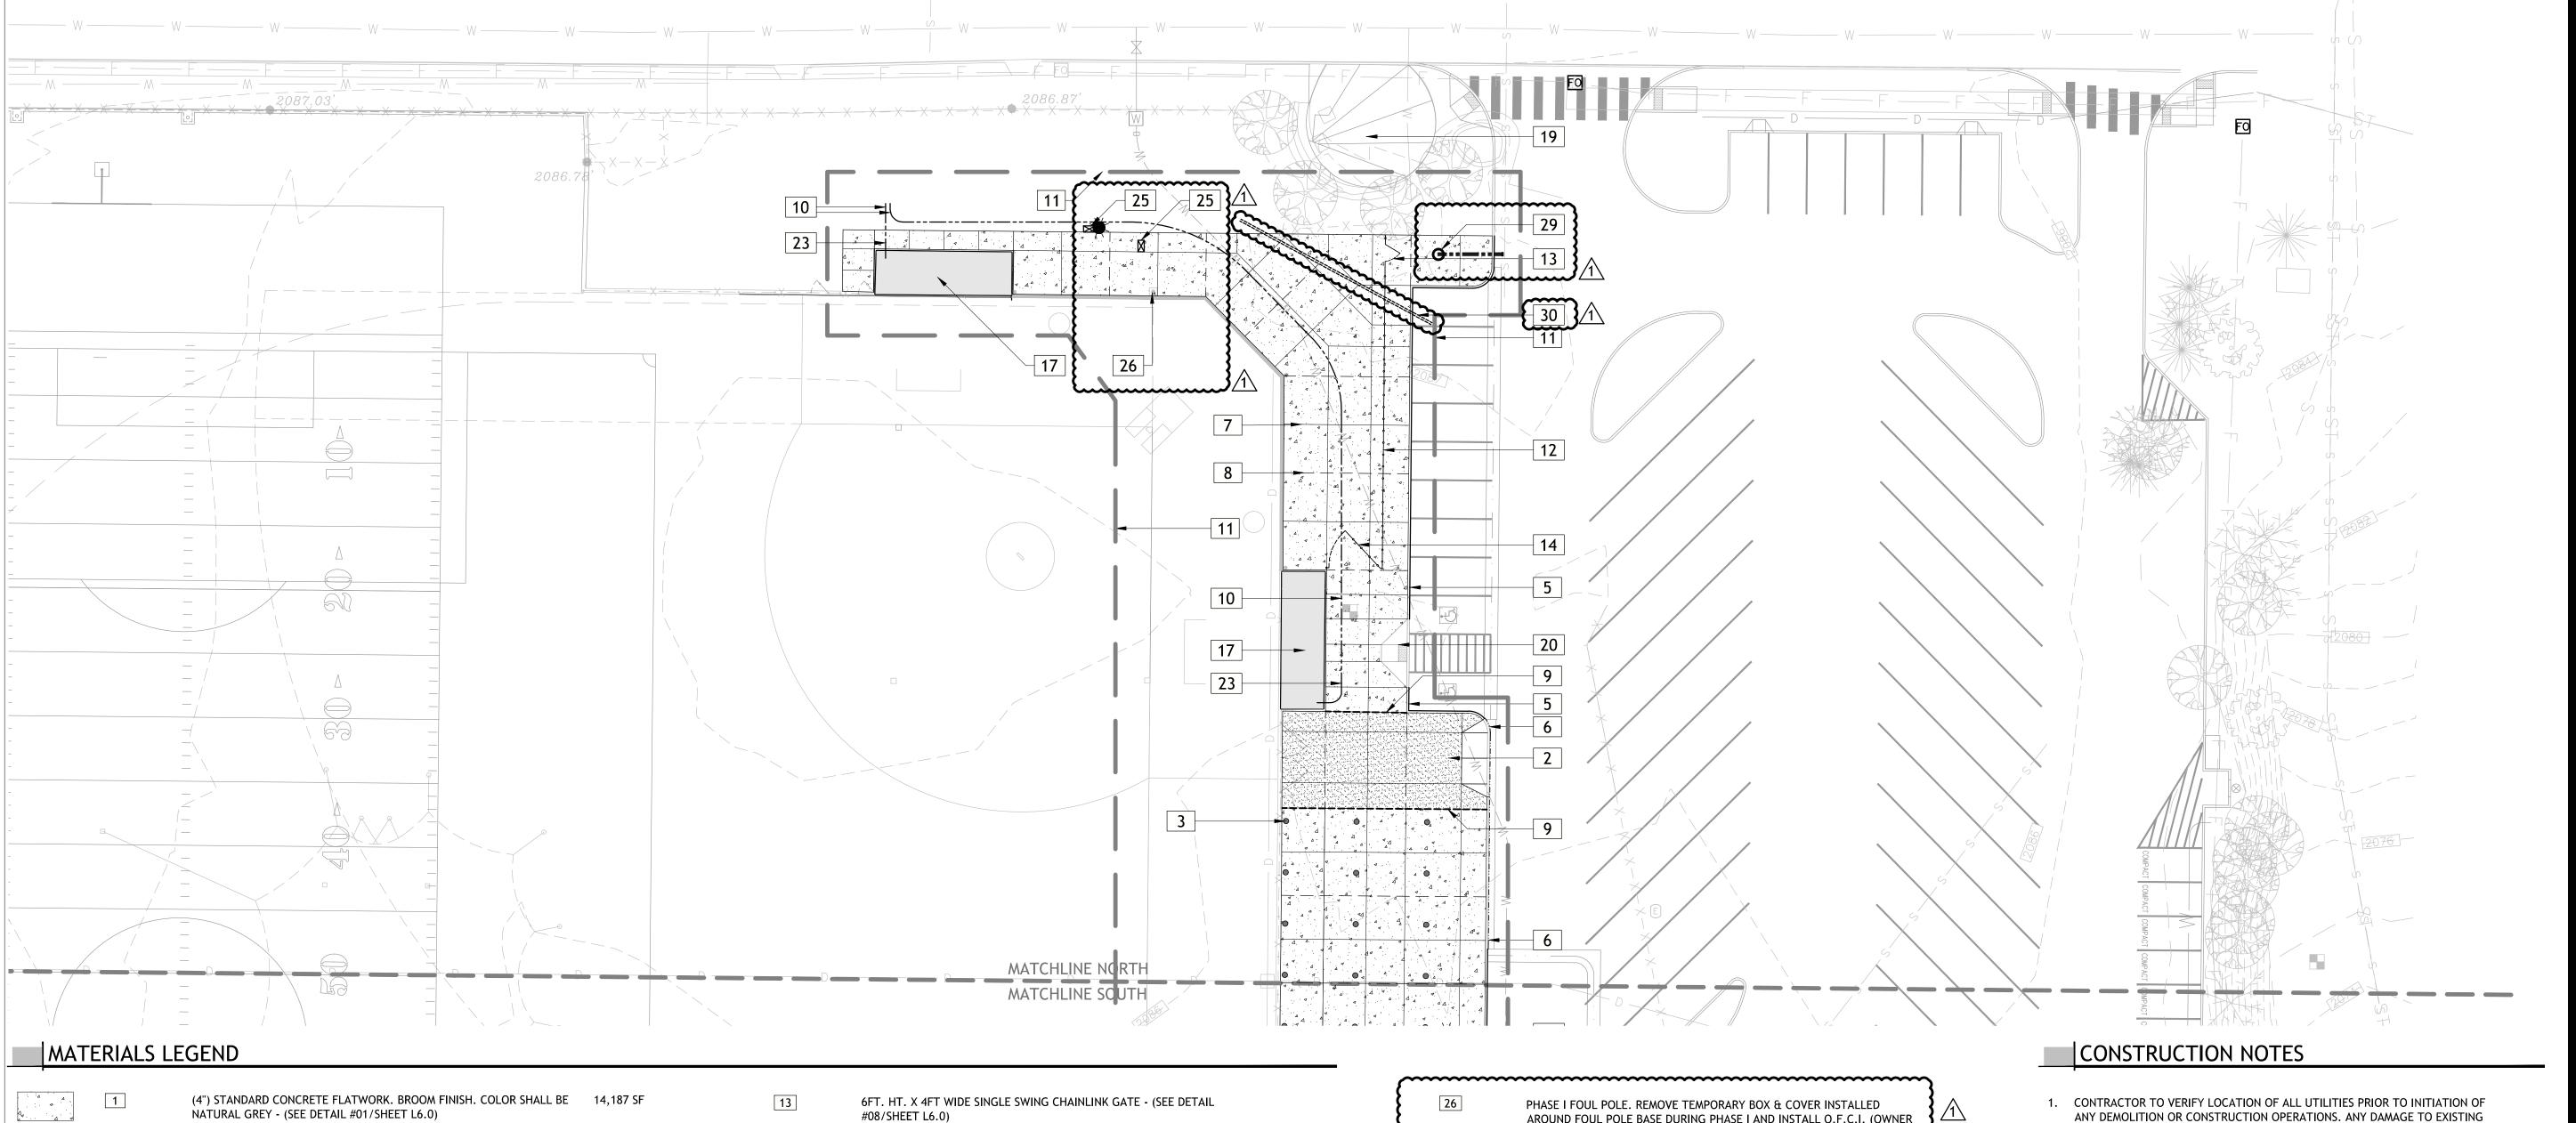

4 · · ·		NATURAL GREY - (SEE DETAIL #01/SHEET L6.0)	14,107 31	13	#08/SHEET L6.0)
2	2	(6") THICKENED CONCRETE FLATWORK AT TRUCK DRIVE APPROACH. #4 REBAR AT 12" O.C. BROOM FINISH, COLOR SHALL BE NATURAL GREY -	990 SF	14	6FT. HT. X 12FT. WIDE SINGLE SWING CHAINLINK GATE - (SEE DETAIL #08/SHEET L6.0)
		(SEE DETAILS #02/SHEET L6.0 & CIVIL SHEETS C1.2 & DETAIL #03/SHEET C2.1)		15	FIRST BASE BASBALL DUGOUT - (SEE DETAILS #01, 02, 03, 05, 06, & 07/SHEET L6.1)
	SYMBOL	DESCRIPTION	<u>QTY</u>	16	THIRD BASE BASEBALL DUGOUT & STORAGE STRUCTURE - (SEE DETAILS #03 - #07/SHEET L6.1 & DETAILS 01, 03, & 05/SHEET L6.3)
•	3	CONCRETE EMBEDDED GROUND SLEEVE FOR BATTING CAGE POSTS. 2-3/8" O.D. X 27" DEEP SLEEVE W/ HINGED ALUMINUM CAP - (SEE DETAIL	21	17	EXISTING SOFTBALL DUGOUT TO REMAIN (PHASE I)
		#06/SHEET L6.0)		18	EXISTING LIGHT FIXTURE TO REMAIN (PHASE I)
4	NEW CAST-IN-PLACE CONCRETE RETAINING WALL W/ EMBEDDED FENCE	192 LF	19	EXISTING WAR MEMORIAL - PRESERVE & PROTECT	
			POSTS - (SEE STRUCTURAL SHEETS & DETAIL #01/SHEET S0.1. SEE DETAILS #01-04/SHEET L6.3) DAYLIGHT PER CIVIL PLANS	20	ADA COMPLIANT STANDARD CAST IRON TACTILE WARNING TILES & PEDESTRIAN RAMP - (SEE CIVIL SHEETS & DETAIL SHEET C2.2)
	5	CONCRETE VERTICAL CURB - (SEE CIVIL SHEETS & DETAIL #01/SHEET C2.1)	245 LF	21	ALTERNATE NO. 01 (ALT. #01) - SUBSTITUTE THE BASE BID FULL-SPAN W10X54 STEEL I-BEAM WITH (2) TWO MID-SPAN W10X12 STEEL I-BEAMS
	6	CONCRETE CURB & GUTTER - (SEE CIVIL SHEETS & DETAIL #02/SHEET C2.1)	67 LF		W/ ADDITIONAL ADDED CENTER SUPPORT TUBE STEEL POST WITH TOP & ANCHOR PLATE - (SEE DETAILS #02, 04, & 06/SHEET L6.3) FOR ADDITIONAL INFORMATION
	7	CONCRETE CONTROL JOINT, TYP (SEE DETAIL #04/SHEET L6.0)	2,123 LF	22	REMOVE HAND HOLE & EXTEND (1") SCHEDULE 40 PVC ELECTRICAL
	8	CONCRETE EXPANSION JOINT, TYP (SEE DETAIL #05/SHEET L6.0)	637 LF		CONDUIT TO SOUTHEAST CORNER BEHIND BENCH, & NORTH OF BAT/HELMET RACK. STUB UP & CAP
	9	CONCRETE W/ THICKENED EDGE & EXPANSION JOINT W/ DOWEL & GREASE SLEEVE - (SEE DETAIL #03/SHEET L6.0)	80 LF	23	EXTEND EXISTING (1") SCHEDULE 40 PVC ELECTRICAL CONDUIT FROM DUGOUT TO THE NORTH TO CLEAR THE FLATWORK AREA
	10	(1") SCHEDULE 40 PVC ELECTRICAL CONDUIT, STUB UP & CAP ENDS. CONDUIT DEPTH PER ELECTRICAL CODE, MINIMUM (18-INCHES)	328 LF	- 24	DEMO EXISTING CHAINLINK FENCE. INCIDENTAL TO EXCAVATION AND 107 LF HAUL OFF-SITE PAY ITEM
	11	PROJECT WORK BOUNDARY EXTENTS	~~ {	25	PHASE I ELECTRICAL HANDHOLE. INSTALL NEW BOX AT SAME LOCATION
	12	6FT. GALVANIZED CHAINLINK FENCE - (SEE SPECIFICATIONS & DETAIL	300 LF) 1		W/ TRAFFIC RATED STEEL OR CONCRETE LID (SUBMIT TO ENGINEER & LANDSCAPE ARCHITECT FOR APPROVAL). SET IN-LINE TO PHASE 2A

CONCRETE FLATWORK AND ADJUST TO FINISH GRADE. INCIDENTAL TO

CONCRETE FLATWORK PAVEMENT PAY ITEM

26	PHASE I FOUL POLE. REMOVE TEMPORARY BOX & COVER INSTALLED AROUND FOUL POLE BASE DURING PHASE I AND INSTALL O.F.C.I. (OWNER FURNISHED, CONTRACTOR INSTALLED) REMOVABLE FOUL POLE BOX W/ACCESS HATCH. THIS COST SHALL BE INCIDENTAL TO THE CONCRETE FLATWORK PAVEMENT PAY ITEM
	·

REMOVE EXISTING HANDHOLE. INCIDENTAL TO CONCRETE FLATWORK PAVEMENT PAY ITEM

INSTALL NEW HANDHOLE W/ TRAFFIC RATED STEEL OR CONCRETE LID (SUBMIT TO ENGINEER & LANDSCAPE ARCHITECT FOR APPROVAL) DIRECTLY EAST OF BATTING CAGE. SET IN-LINE TO PHASE 2A CONCRETE FLATWORK AND ADJUST TO FINISH GRADE. RE-ROUTE PHASE I WIRE/CONDUIT TO THIS LOCATION AND ROUTE CONDUIT TO INSIDE BATTING CAGE. INCIDENTAL TO CONCRETE FLATWORK PAVEMENT PAY

APPROXIMATE LOCATION OF THREE (3) 1-INCH UNDERGROUND PHASE I ELECTRICAL CONDUITS 5FT. SOUTH, AND 20FT. EAST OF FROST-FREE WATER SPIGOT. CAREFULLY POTHOLE/EXCAVATE & EXTEND CONDUITS PAST PHASE 2A CONCRETE FLATWORK EXTENT TO THE EAST MINIMUM 3FT. BEYOND

INSTALL 6-INCH DIAMETER CLASS 200 PVC SLEEVE FOR FUTURE IRRIGATION MAINLINE ROUTING. INCIDENTAL TO CONCRETE FLATWORK PAVEMENT PAY ITEM

* ALL QUANTITIES PROVIDED SHALL BE CONFIRMED BY CONTRACTOR AND ARE SHOWN FOR REFERENCE ONLY. IN THE CASE OF A DISCREPANCY BETWEEN THE SCHEDULE AND PLAN, THE PLAN LOCATION(S) SHALL DICTATE QUANTITY.*

- UTILITIES ON SITE OR ADJACENT PROPERTY SHALL BE CONTRACTOR'S RESPONSIBILITY TO CORRECT.
- 2. COORDINATE ALL DEMOLITION AND CONSTRUCTION OPERATIONS WITH CIVIL & STRUCTURAL ENGINEERING SHEETS.
- 3. COORDINATE INSTALLATION OF ELECTRICAL CONDUIT AND SLEEVES WITH RESPECTIVE CONTRACTORS.
- 4. PROVIDE TOOLED SCORE JOINTS AS SHOWN ON PLANS. SCORE JOINTS ARE AN INTEGRAL PART OF THE DESIGN AND SHALL NOT VARY FROM PATTERNS AND LOCATIONS SHOWN. CONTRACTOR SHALL REMOVE ANY FLATWORK THAT DOES NOT CONFORM TO DESIGN.
- 5. CONTRACTOR SHALL REFER TO SPECIFICATIONS FOR ADDITIONAL REQUIREMENTS. 6. CONTRACTOR RESPONSIBLE FOR CORRECTING ANY DAMAGE TO NEW OR EXISTING CONCRETE FLATWORK, ASPHALT, TURF AREAS OR ANY OTHER EXISTING
- ELEMENTS AS A RESULT OF CONSTRUCTION ACTIVITIES. 7. IN THE EVENT OF A DISCREPANCY, IMMEDIATELY NOTIFY LANDSCAPE ARCHITECT.

 \leq 0

()

C E


Field : - Phase

Improvements - I Spring Facilities


Project No: 19-10-207

Drawn by:

JNDERGROUND SERVICE ALERT ONE-CALL NUMBER

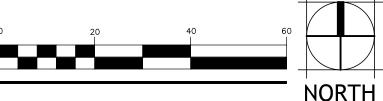

#07/SHEET L6.0)

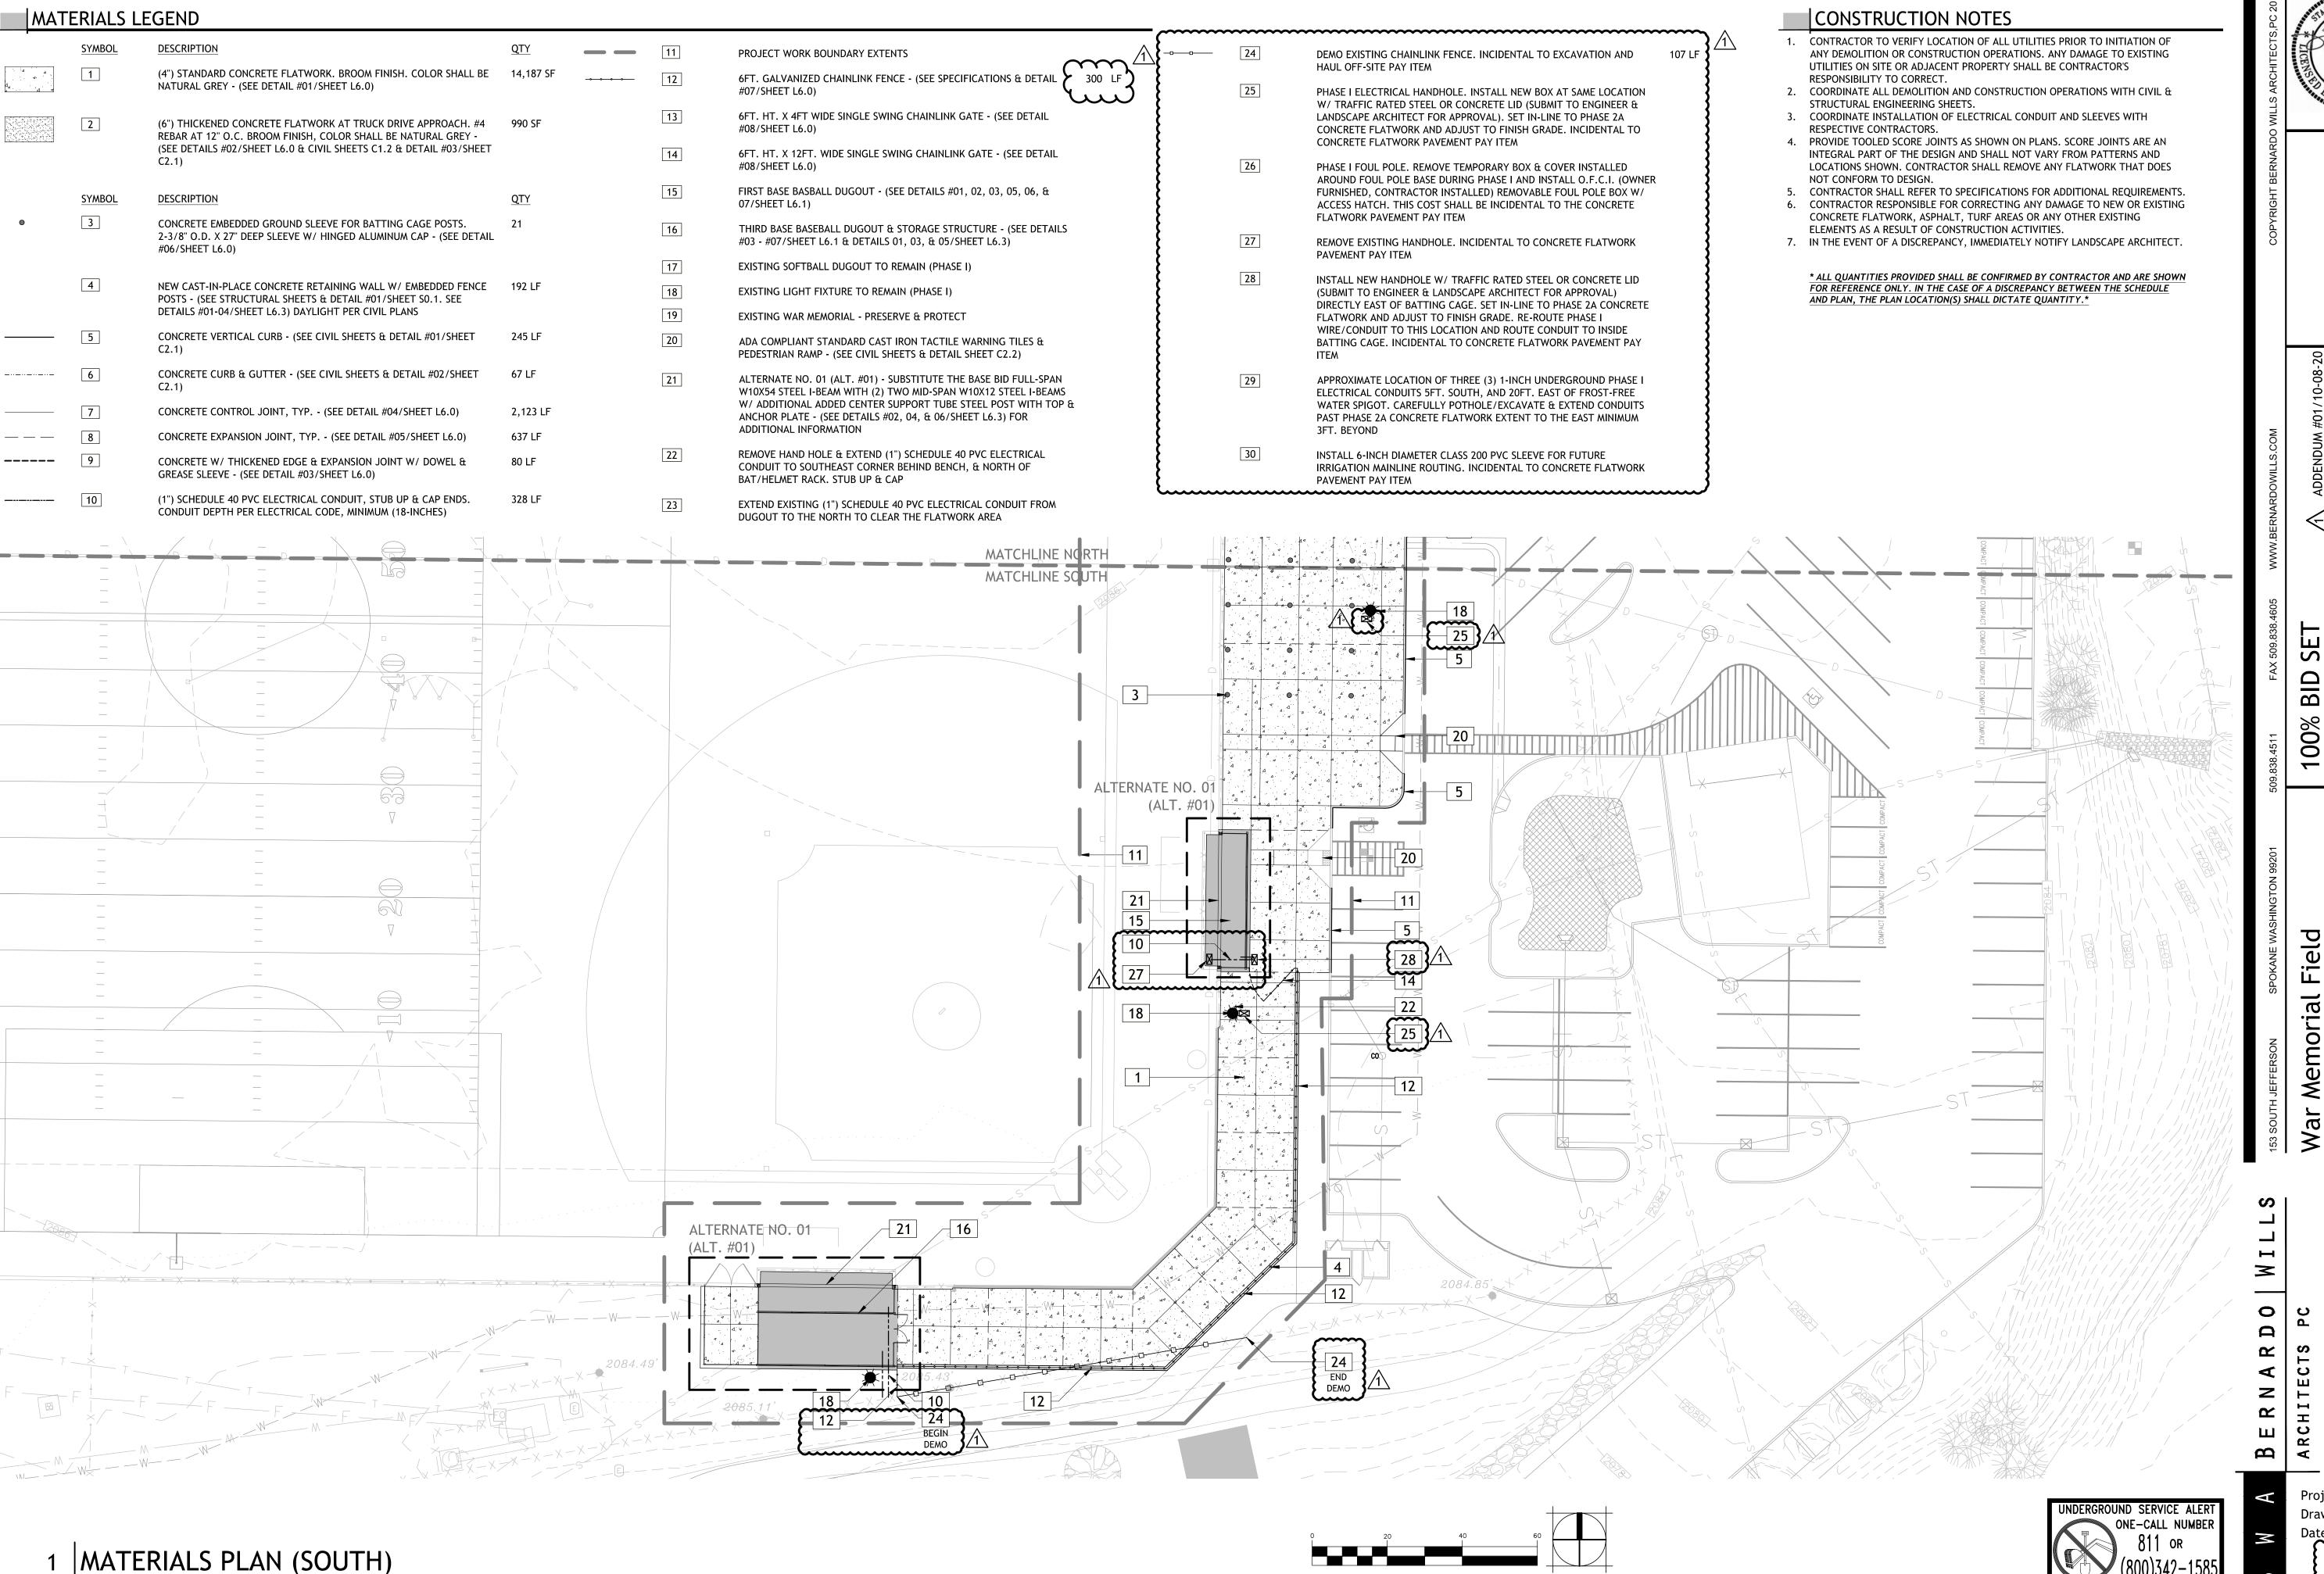

Drawn by:

0